126 Chandler St


Worcester Common Ground



Drawing Title	Sheet Number
Site Map	A101
North Elevation	A102
South Elevation	A103
Greenhouse Floor Plan	A104
Egress Plan	A105
Greenhouse to Roof Connection	A106
Knee Wall Connection	A107
Mullion System Connection	A108
Polycarbonate Window Opening	A109
Gutter Detail	A110
Bill Of Materials	A111
Greenhouse Interior Render	A112
Greenhouse Exterior Render	A113
Existing Mechanical Roof Plan	M101
Proposed Mechanical Roof Plan	M102
Greenhouse HVAC plan	M103
Greenhouse Structure	S101
Strucure Details	S102
Proposed Roof Plan	S103
Proposed Floor Framing	S104
Modifications of Steel Framing	S105



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17045.00	
02.21.2018	A101
Author	, (101
Checker	Scale
_	02.21.2018 Author
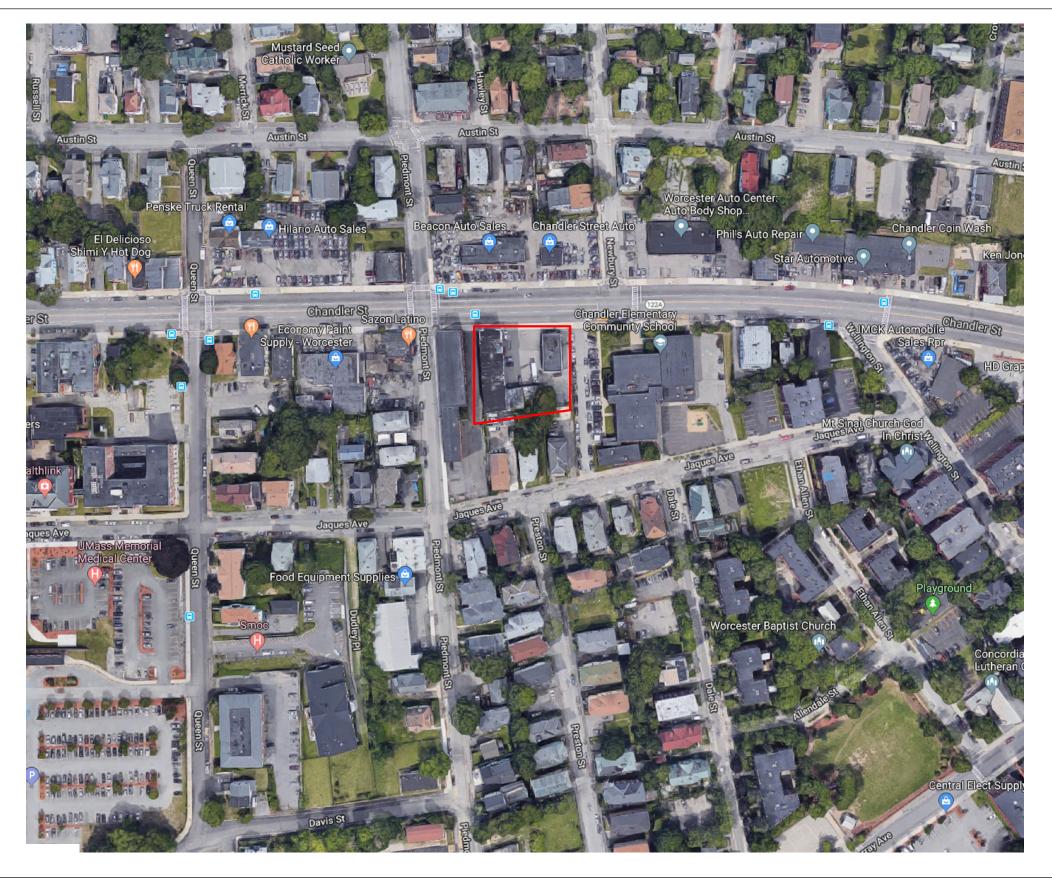
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No.	Description	Date


North Ele	evation		
Project number	17045.00		
Date	02.21.2018	A102	
Drawn by	Author	7 (102	
Checked by	Checker	Scale 1/8" = 1'-0"	





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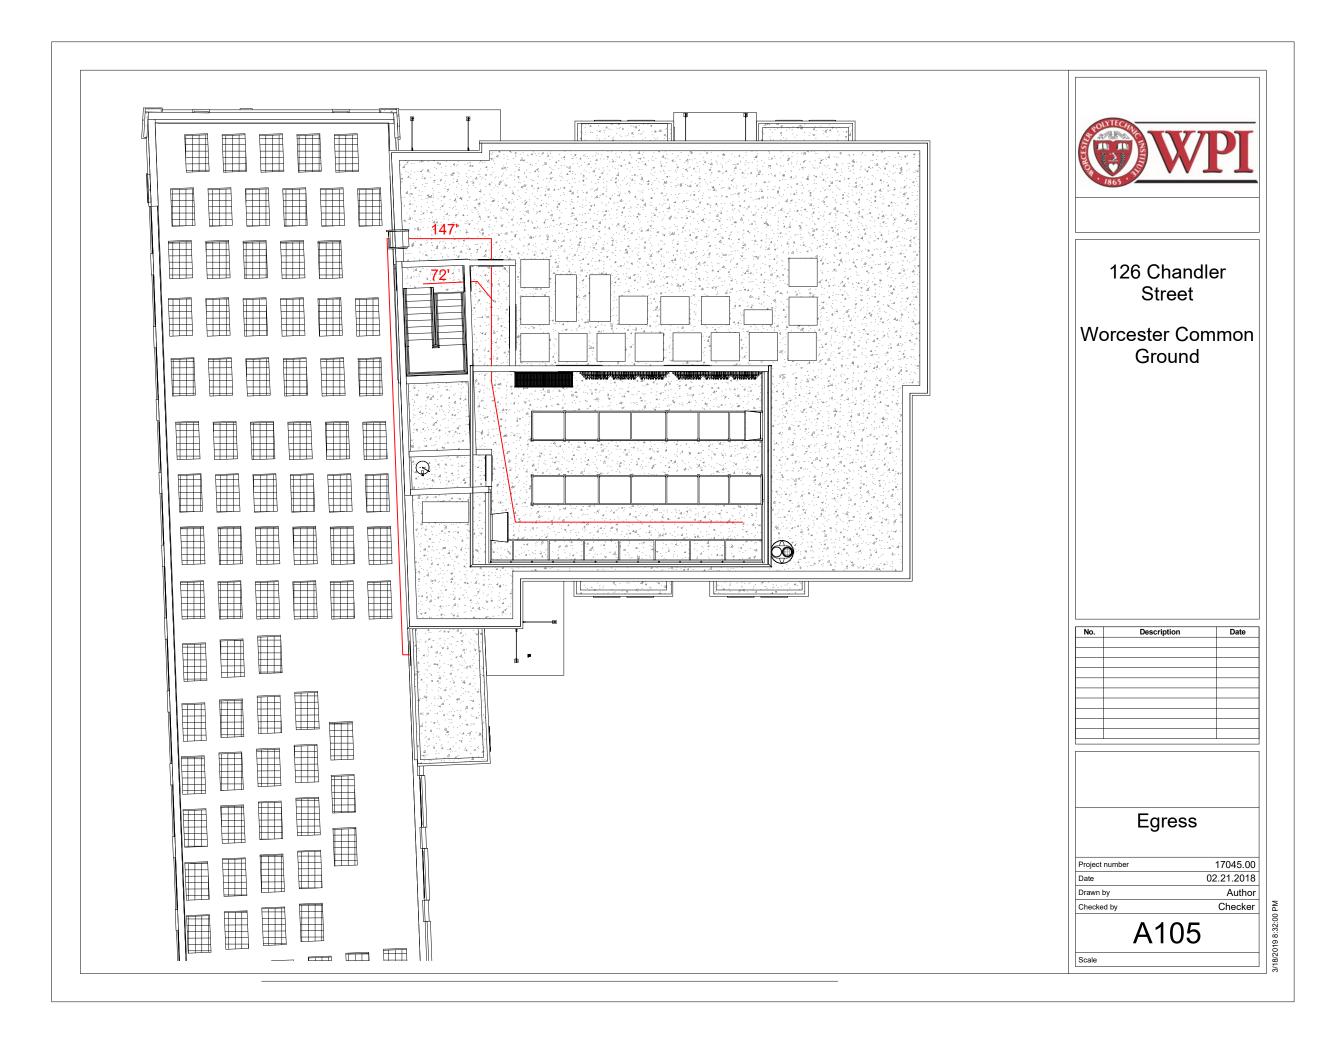
South El	evation	
Project number	17045.00	
Date	02.21.2018	A103
Drawn by	Author	
Checked by	Checker	Scale 1" = 10'-0"




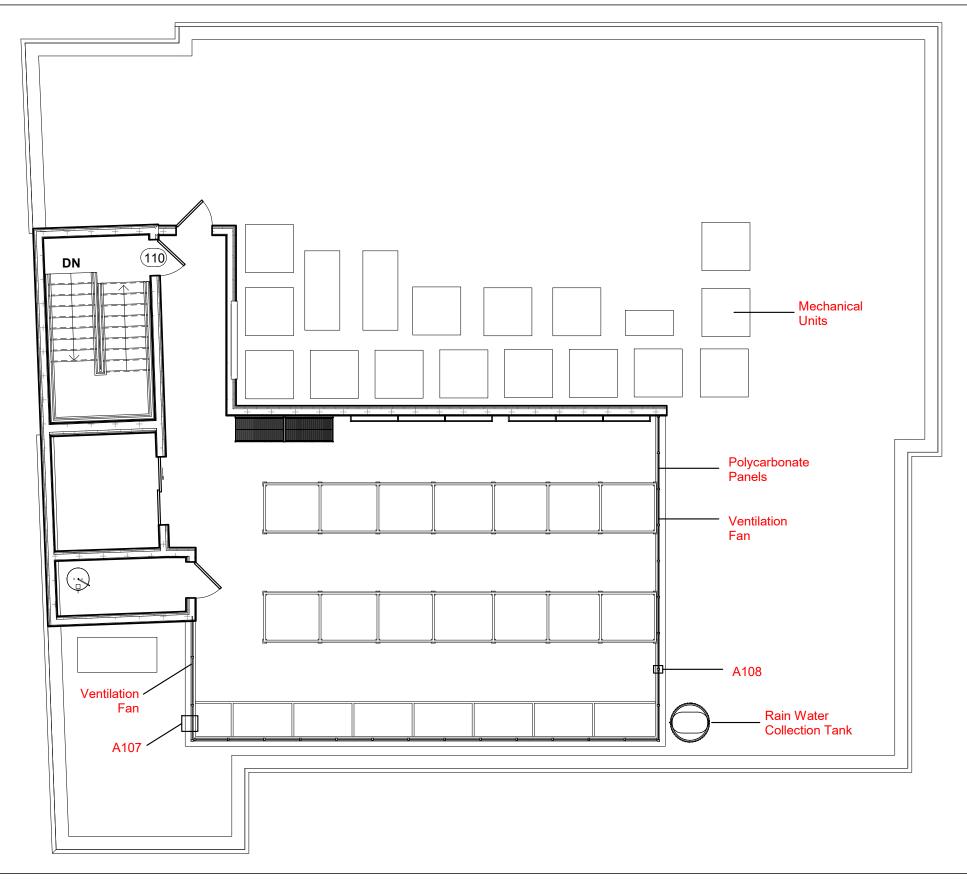

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Greenho	use Floor P	lan	
Project number	17045.00		
Date	02.21.2018	A104	
Drawn by	Author		
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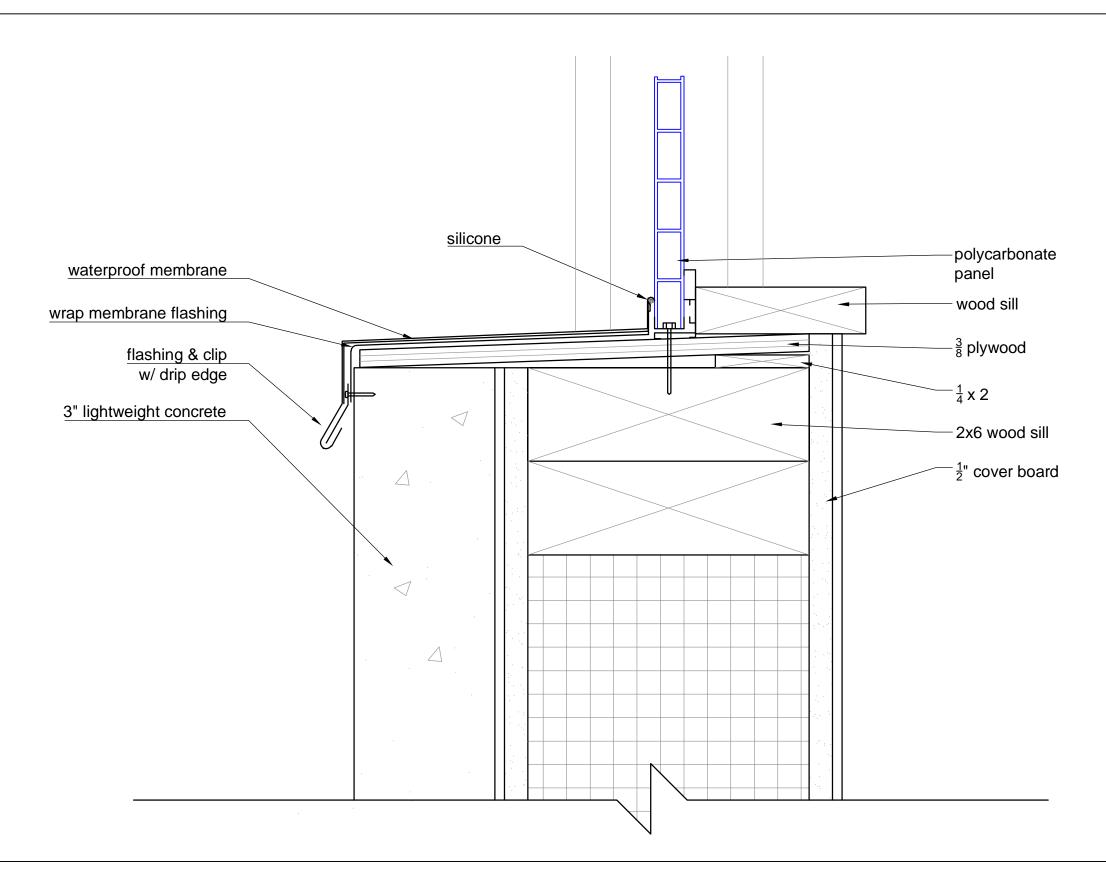
Worcester Common Ground

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Greenhouse to Roof Connection

Project number	17045.00	
Date	02.21.2018	A106
Drawn by	Author	71100
Checked by	Checker	Scale 1:5
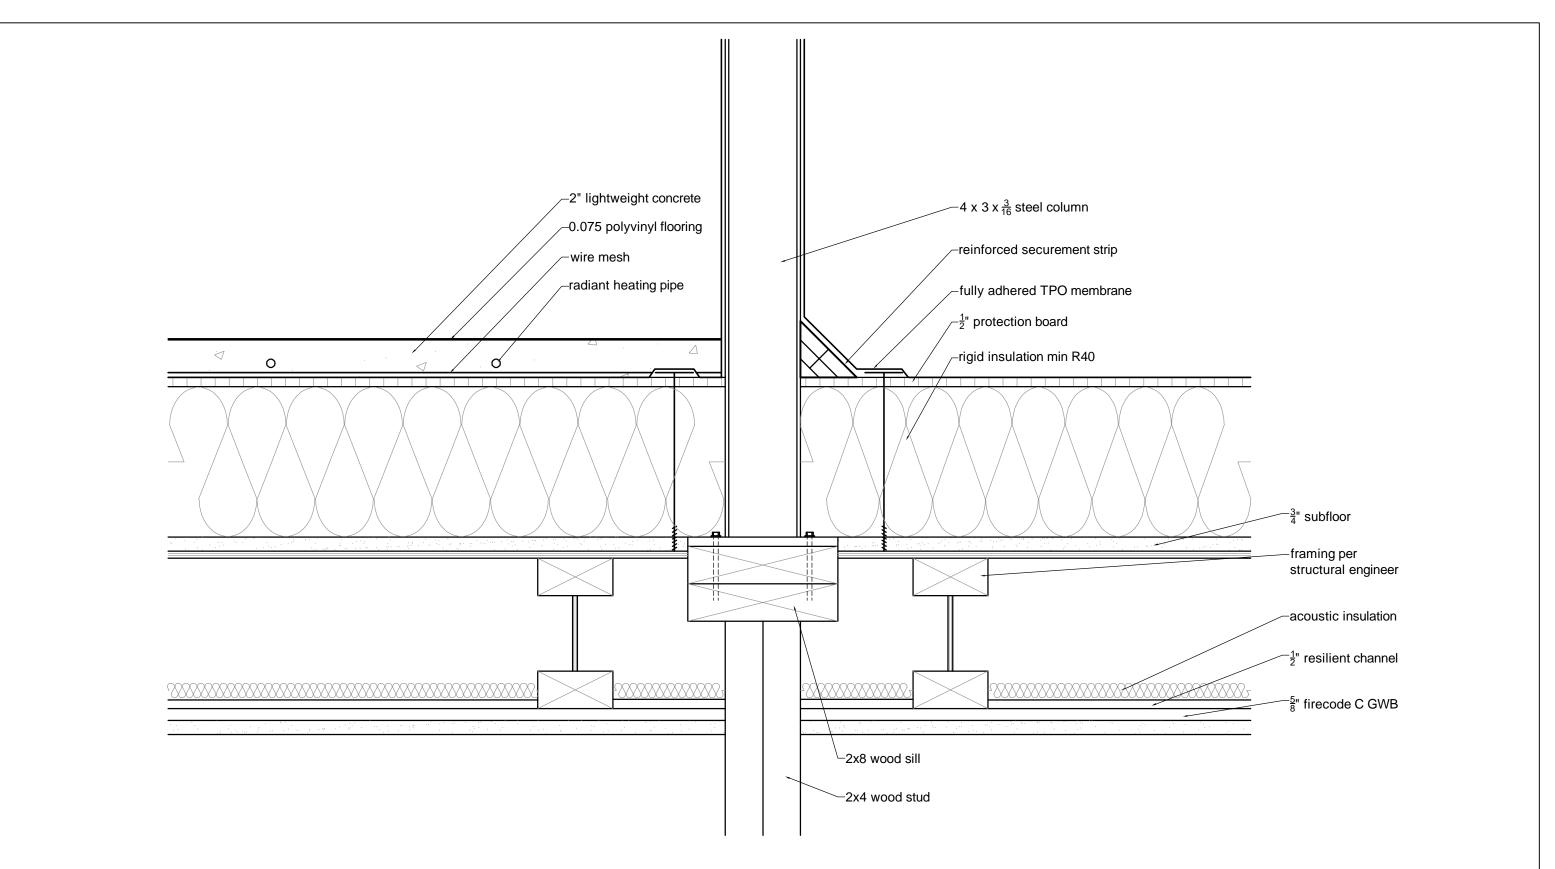
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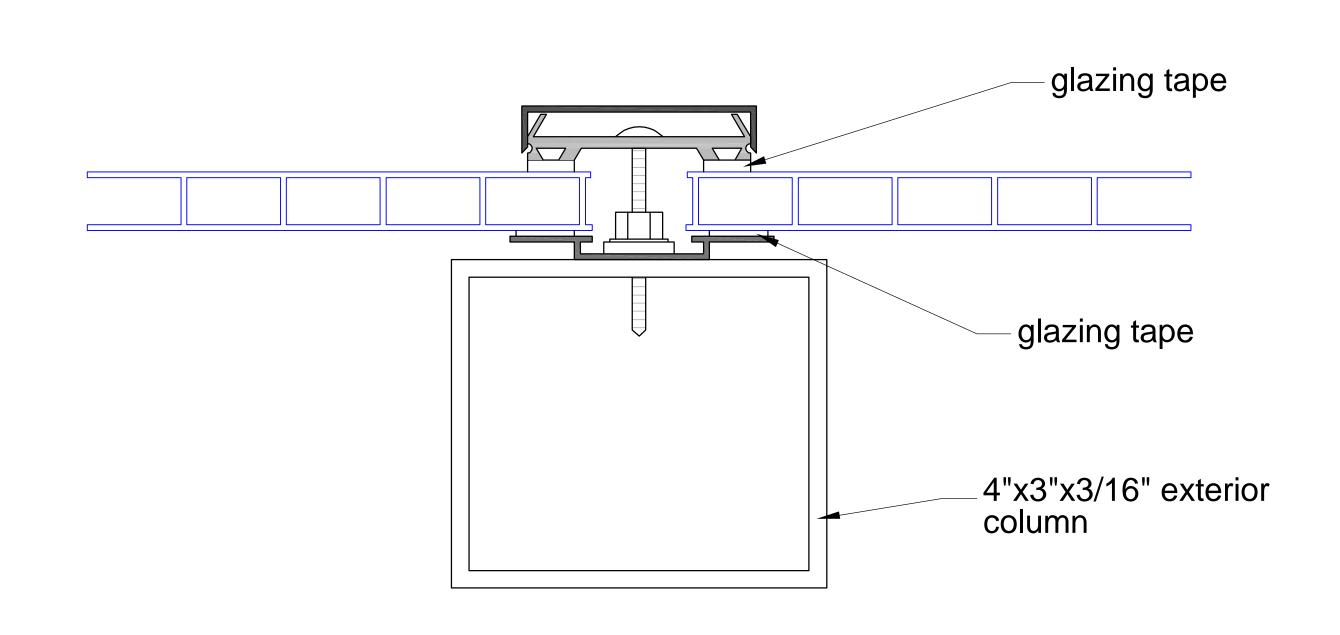


Worcester Common Ground

No.	Description	Date

Knee Wall Connection				
Project number	17045.00	A 4 0 =		
Date	02.21.2018	A107		
Drawn by	Author	, , , , ,		
Checked by	Checker	Scale 1:2		

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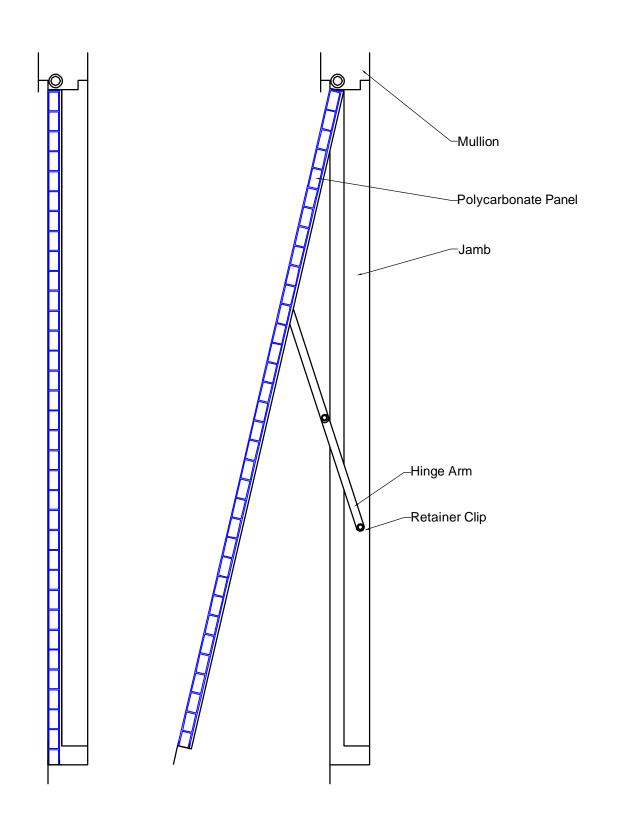




Worcester Common Ground

No.	Description	Date

Project number 17045.00	
Date 02.21.2018 A 1 0 8	
Drawn by Author	
Checked by Checker Scale 1:1	






Worcester Common Ground

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Polycarbonate Window Opening

Project number	17045.00	
Date	02.21.2018	\square A109
Drawn by	Author	7 (100
Checked by	Checker	Scale 1:4

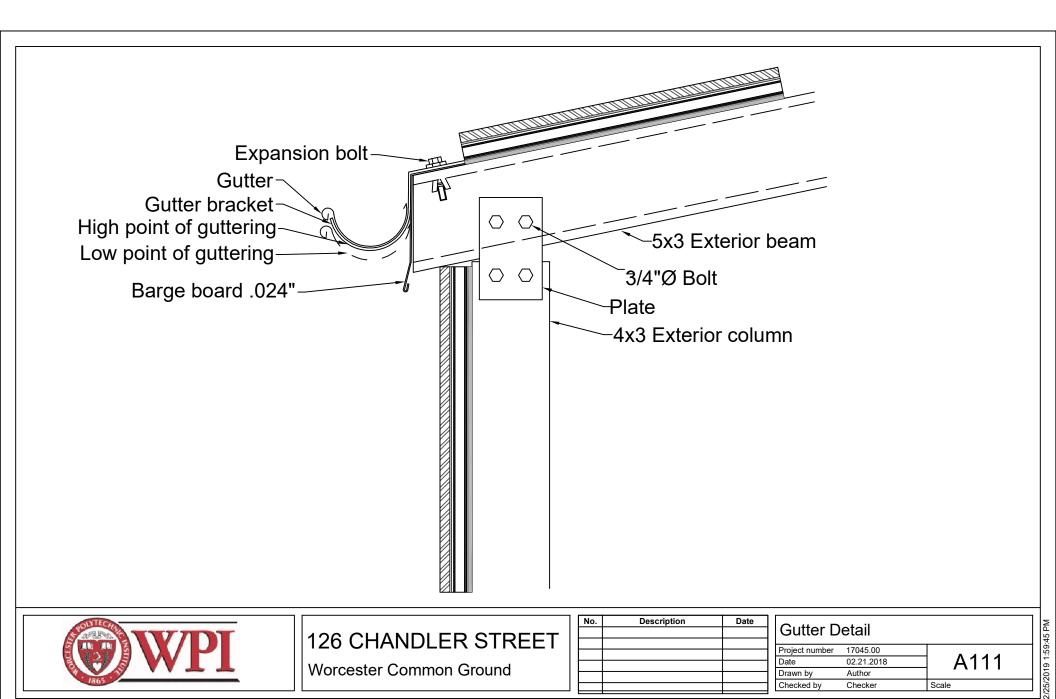

Worcester Common Ground

Project number

Checked by

17045.00

Checker

02.21.2018

A111


It	tem	Size	Model	Manufacturer	Number of Units	Unit Price	Total Price
Polycarbo	nate Panels	3'x4' 5/8" thickness	16mm Policarb, 3 Wall Clear	GallinaUSA	160	\$ 46.40	\$ 7,424.00
Mullion	n System	1"	F Channel	Stergis	772.25	\$ 1.80	\$ 1,390.05
	Piping	1/2" tubing	1/2" PEX Tubing	Radiantec	1000	\$ 0.80	\$ 800.00
Radiant heating system	Thermostat, relay controls, other	-varies-	-varies-	Radiantec	1	\$ 1,875.00	\$ 1,875.00
system	Water Heater	38 gallons, dim: 1.6'x1.6'x4.8'	Performance Platinum 36,000 BTU Liquid Propane ENERGY STAR	Rheem	1	\$ 685.00	\$ 685.00
Rainwater H	larvesting Tank	75" diameter by 65" high, 160 lbs.	Polyethylene, 1000 Gallons	Poly-Mart	1	\$ 680.00	\$ 680.00
G	utter	10 ft	10 ft aluminum gutter, gutter end, downspout	Amerimax Home Products	14	\$ 8.00	\$ 112.00
Insulated W	lood Stud Wall	676 sqft			1	\$ 4.36	\$ 2,947.36
F	ans	14" diameter with 1,400 CFM	Strongway Heavy-Duty Fully Enclosed Direct Drive Shutter Exhaust Fan	Northern Tool and Equipment	2	\$ 115.00	\$ 230.00
Q1	0-4	4.5'x4'x1x	Raised Wood Planter Garden Bed Box Stand	Best Choice Products	14	\$ 74.00	\$ 1,036.00
Planti	ng Beds	2.75'x4.75'x1'	Cedar Garden Bed Planter	Greenes Fence	9	\$ 67.30	\$ 605.70
		2.7'x3.75'x.75'	Vertical Planter	Gronomics	1	\$ 259.00	\$ 259.00
	Exterior Beam	HSS 5x3 1/2" thickness	Hot rolled steel, rectangular tube	Midwest Steel and Aluminum	12	\$ 312.87	\$ 3,754.44
Structure	Interior Beam	HSS 6x4 1/2" thickness	Hot rolled steel, rectangular tube	Midwest Steel and Aluminum	4	\$ 399.10	\$ 1,596.40
	Columns	HSS 4x3 3/6" thickness	Hot rolled steel, rectangular tube	Midwest Steel and Aluminum	13	\$ 125.54	\$ 1,632.02
							\$ 25,026.97



Worcester Common Ground

Description	Date
	Description

Bill of Materials		
Project number	17045.00	
Date	02.21.2018	A111
Drawn by	Author	, , , , , ,
Checked by	Checker	Scale
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No.	Description	Date

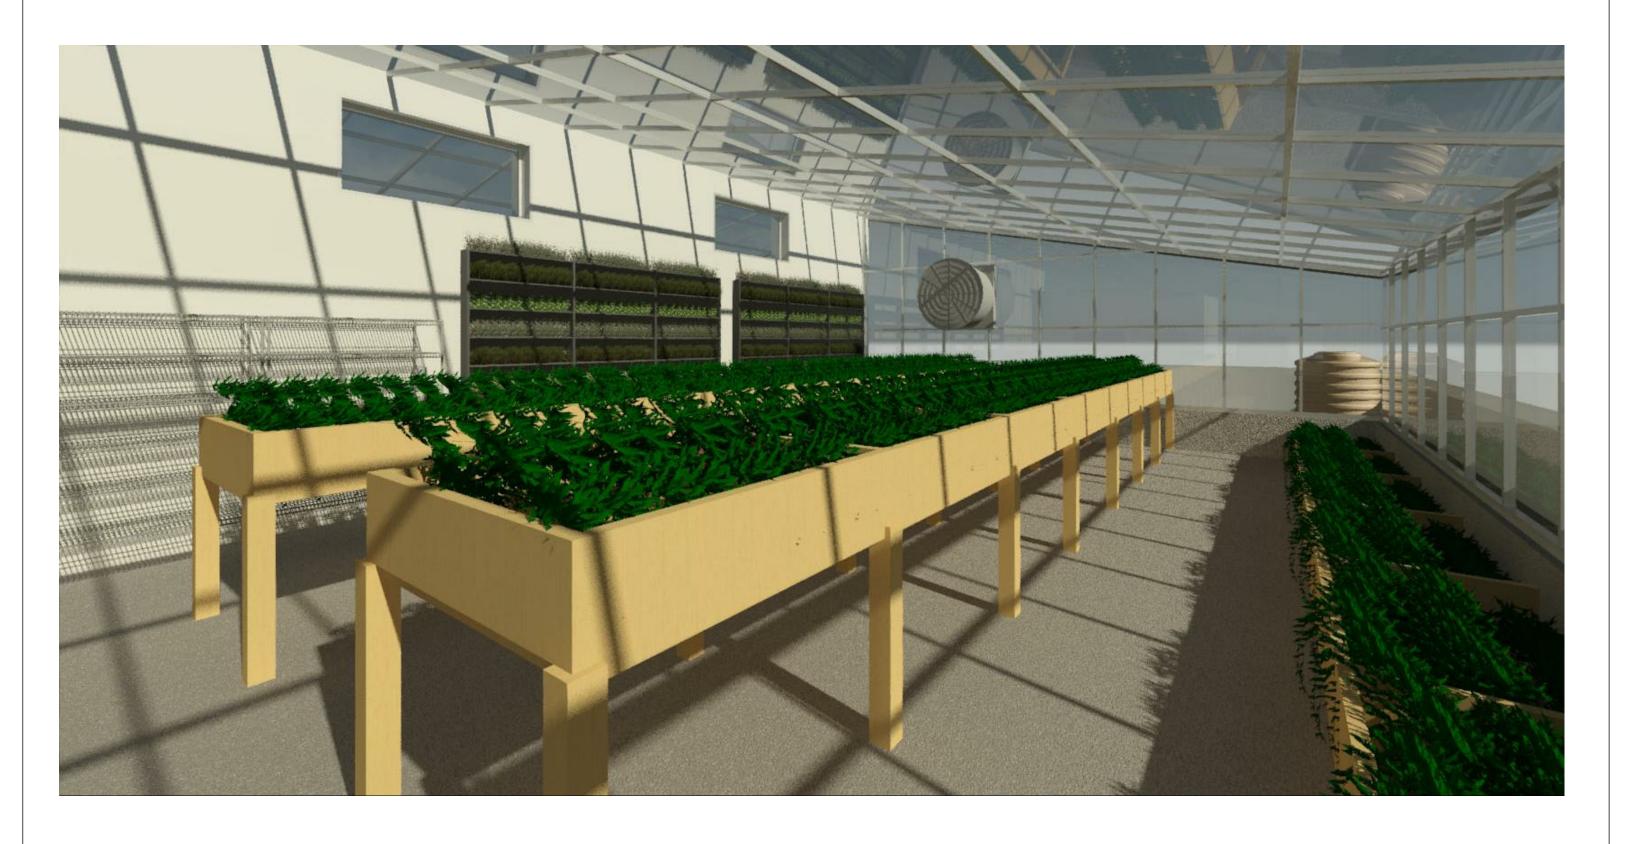
Greenhouse Interior Render			
Project number	17045.00		
Date	02.21.2018	A112	
Drawn by	Author	/ \	
Checked by	Checker	Scale 12" = 1'-0"	





No.	Description	Date

Greenhouse Exterior Render			
Project number	17045.00		
Date	02.21.2018	A113	
Drawn by	Author	, , , , , ,	
Checked by	Checker	Scale 12" = 1'-0"	

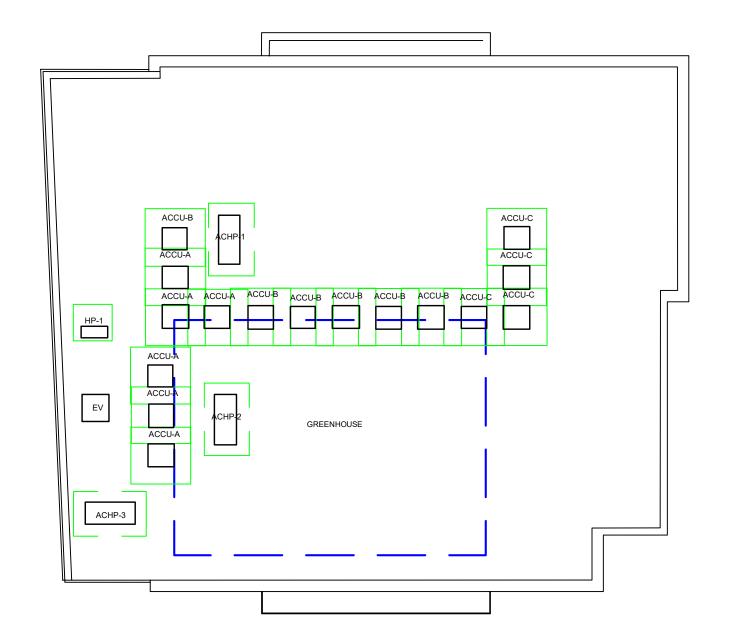




Worcester Common Ground

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Existing Mechanical Roof Plan

Project number	17045.00	
Date	02.21.2018	M101
Drawn by	Author	101101
Checked by	Checker	Scale

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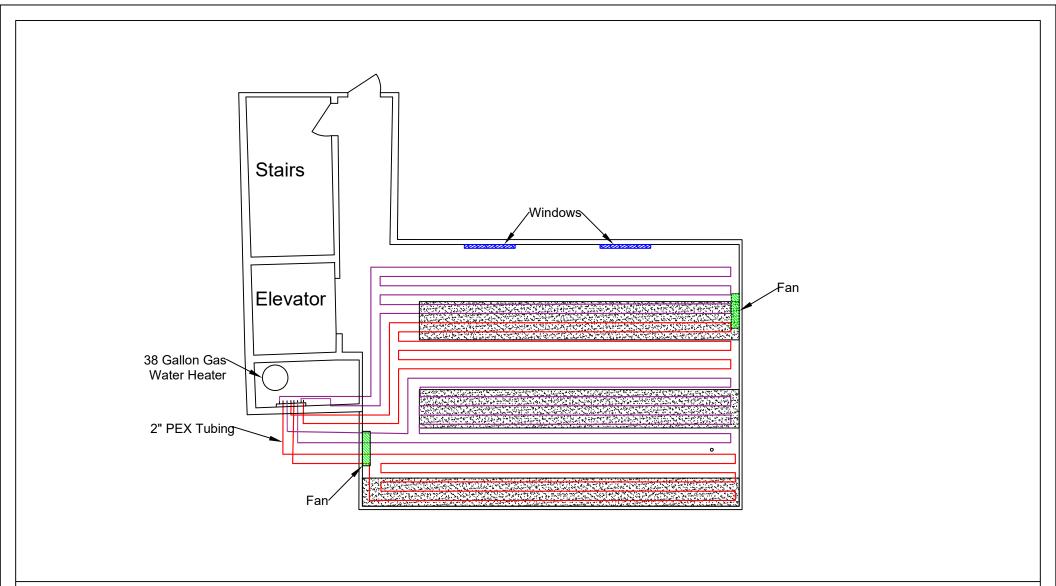


Worcester Common Ground
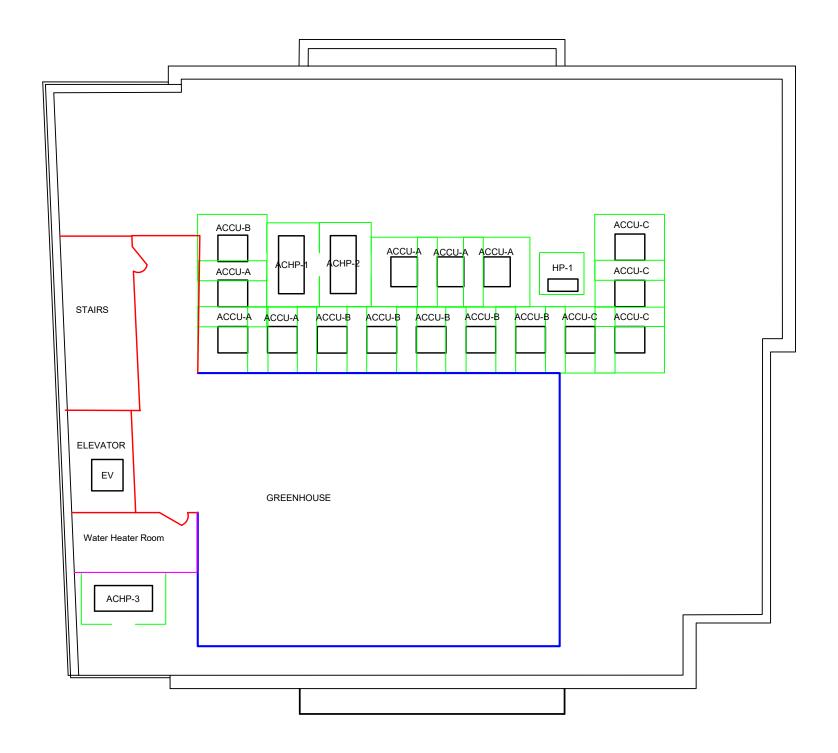
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Project Date			
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Proposed Mechanical Roof Plan

ect number	17045.00	
e	02.21.2018	M102
wn by	Author	
cked by	Checker	Scale






Worcester Common Ground

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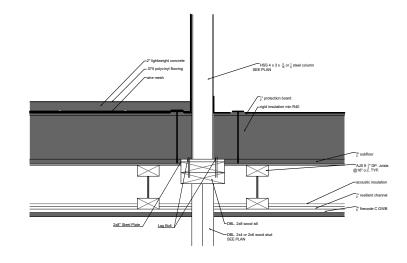
Greenhouse HVAC Plan			
Project number	17045.00		
Date	02.21.2018	A113	
Drawn by	Author	,	
Checked by	Checker	Scale 1/125"=1'	

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Beam Number	Beam Size
B1	HSS 5x3x1/2
B2	HSS 6x4x1/2

Coulmn Number	Column Size
C1	HSS 4x3x1/8
C2	HSS 4x3x3/16

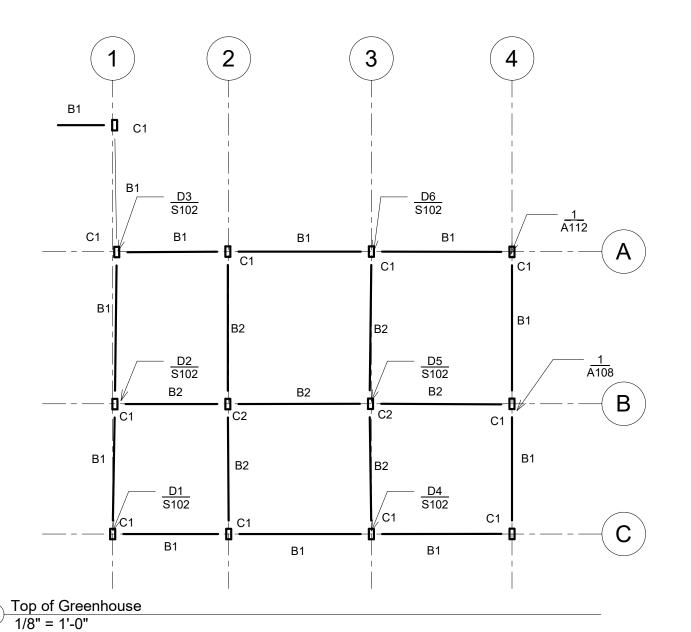



Detail: Structure to Roof Connection TYP. Scale: 1/16" =1"



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126 Chandler Street


Worcester Common Ground


Description	Date
	Description

Greenhouse Structure

Project number	Project Number	
Date	Issue Date	S101
Drawn by	Author	
Checked by	Checker	Scale 1/8" = 1'-0"

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Notes:

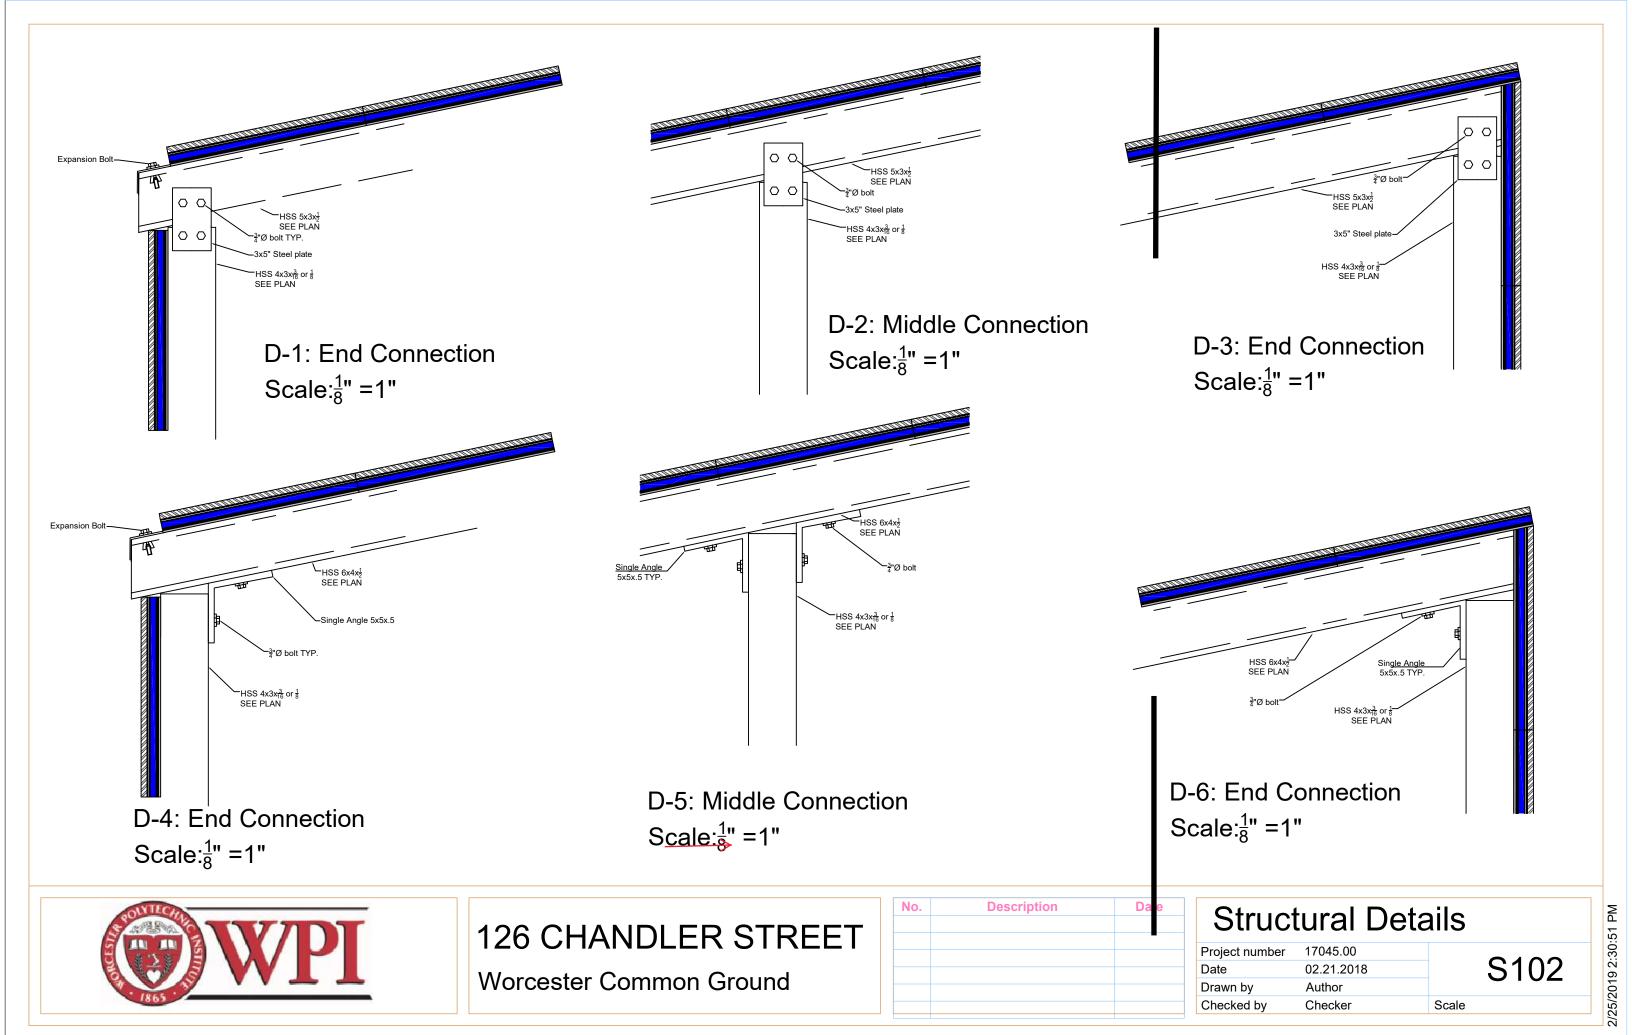- 1. This plan serves to show the modifications made to the structure to accommodate the super imposed greenhouse loads and should not be used as a complete structural drawing
- 2. DBL stands for doubled studs at that location. Below all the columns connected to the greenhouse doubled studs must be placed
- 3. Wall construction is 2x6 Spruce Pine Fir No. 1/2 @16" o.c. wood stud bearing walls unless otherwise noted
- 4. Interior walls marked 2x4 shall be Southern Pine No. 2 @ 16" o.c. wood stud bearing walls unless otherwise noted

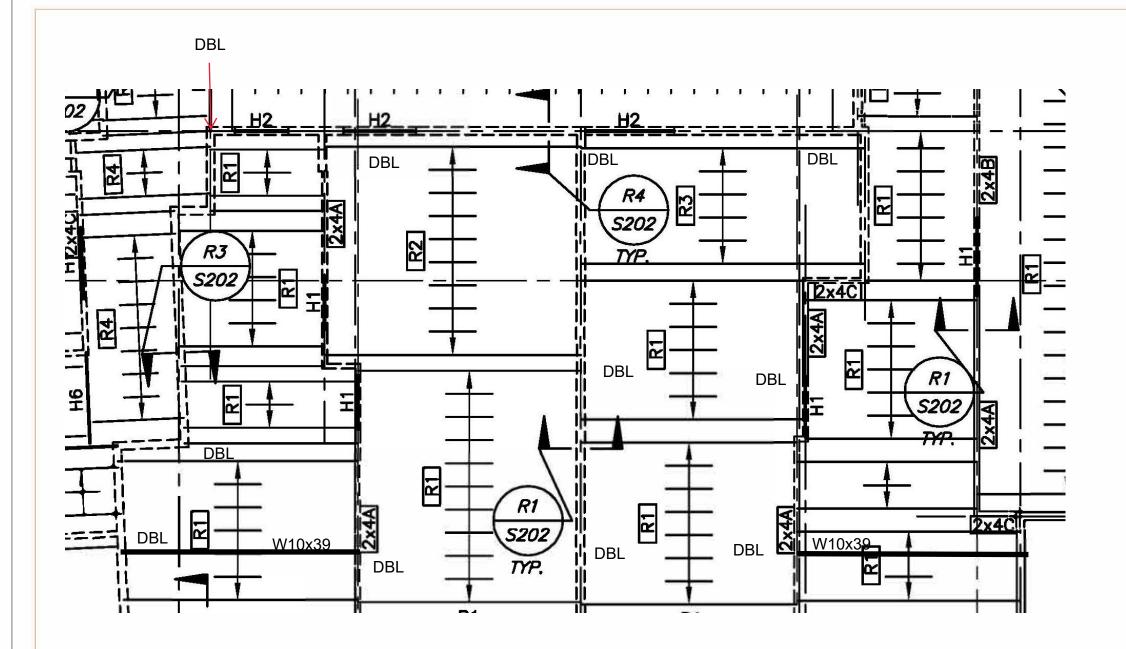


126 CHANDLER STREET

Worcester Common Ground

No.	Description	Date

Proposed Roof Framing

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rawn by	Author	
hecked by	Checker	Scale

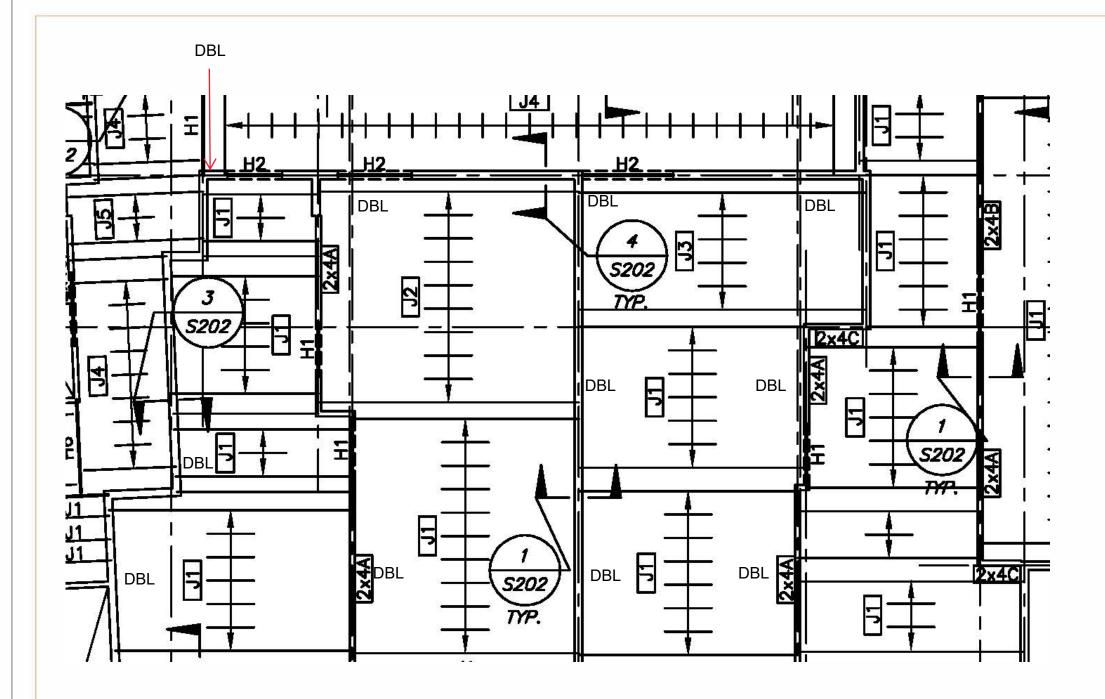

Notes:

- 1. This plan serves to show the modifications made to the structure to accommodate the super imposed greenhouse loads and should not be used as a complete structural drawing
- 2. DBL stands for doubled studs at that location. Below all the columns connected to the greenhouse doubled studs must be placed
- 3. Wall construction is 2x6 Spruce Pine Fir No. 1/2 @16" o.c. wood stud bearing walls unless otherwise noted
- 4. Interior walls marked as "2x4A etc. " shall be as follows 2x4A: 2nd to 3rd: SO. Pine No. 2 @ 8" o.c 3rd to 4th: SO. Pine No. 2 @ 12" o.c. 4th to roof: SPF No. 1/2 @ 16" o.c.



126 CHANDLER STREET


Worcester Common Ground

Description	Date
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	Description

Proposed Floor Framing

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)2.21.2018	S104
Author	0.0.
Checker	Scale
	02.21.2018 Author

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Notes:

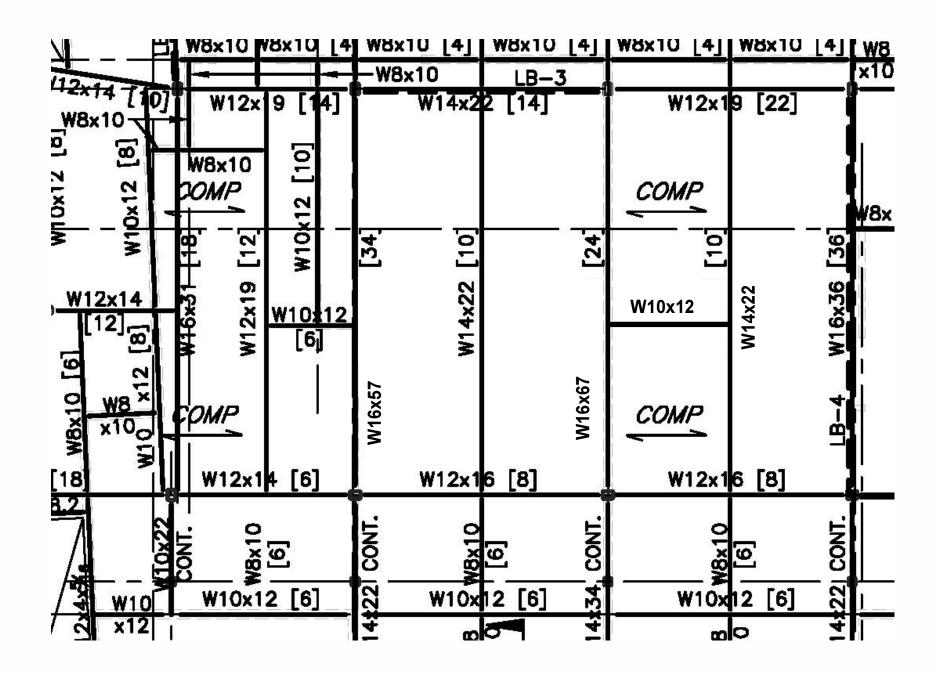1. This plan serves to show the modifications made to the structure to accommodate the super imposed greenhouse loads and should not be used as a complete structural drawing



126 CHANDLER STREET
Worcester Common Ground

NO.	Description	Date
-		

Modification Steel Framing			
Project number	17045.00	0.40.4	
Date	02.21.2018	S104	
Drawn by	Author	• • • • • • • • • • • • • • • • • • • •	
Checked by	Checker	Scale	